




Version: 1, Version Date: 27/08/2025

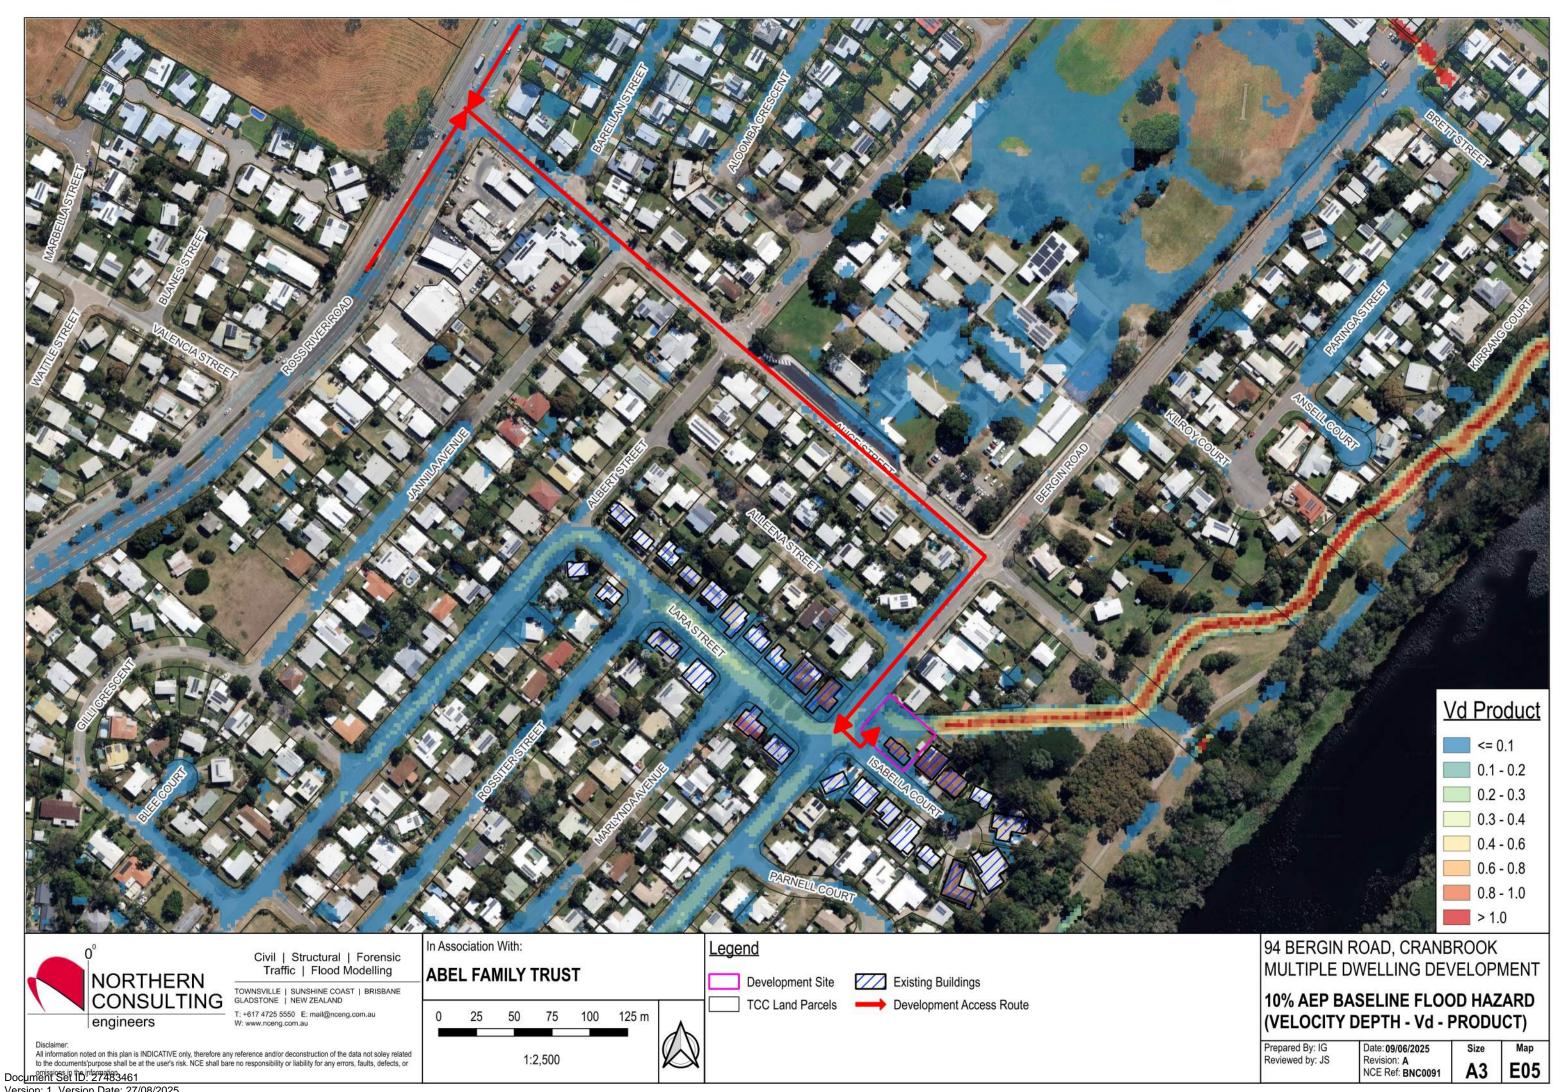

Version: 1, Version Date: 27/08/2025

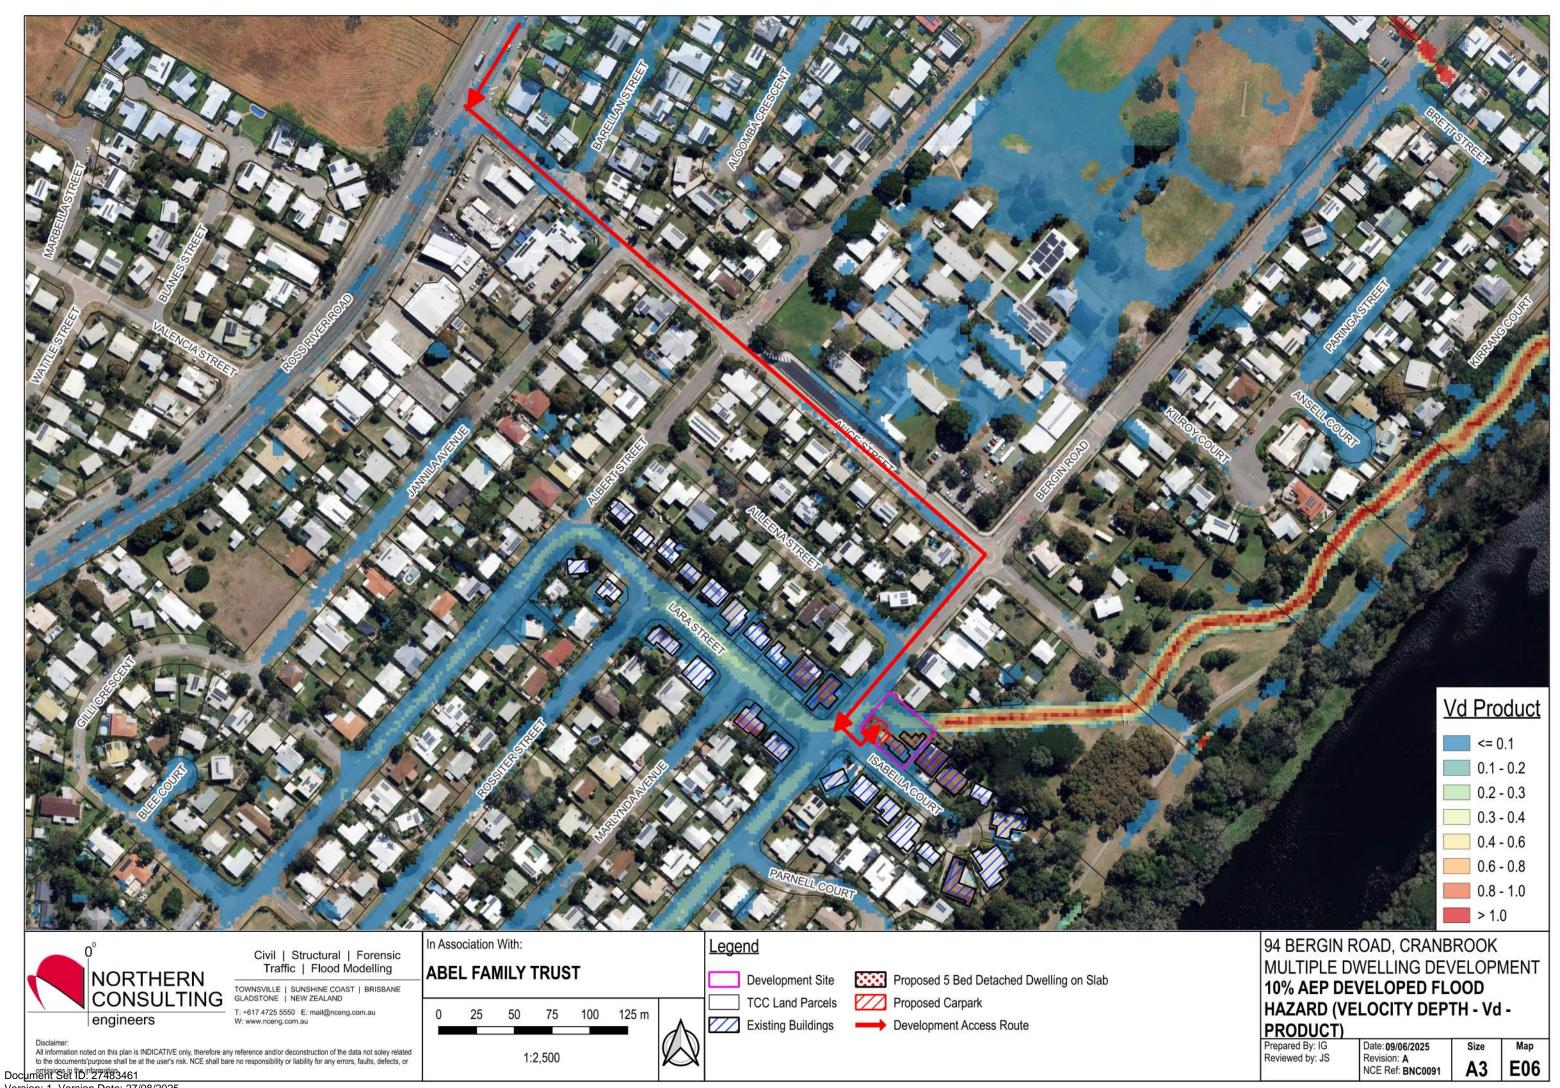

Version: 1, Version Date: 27/08/2025

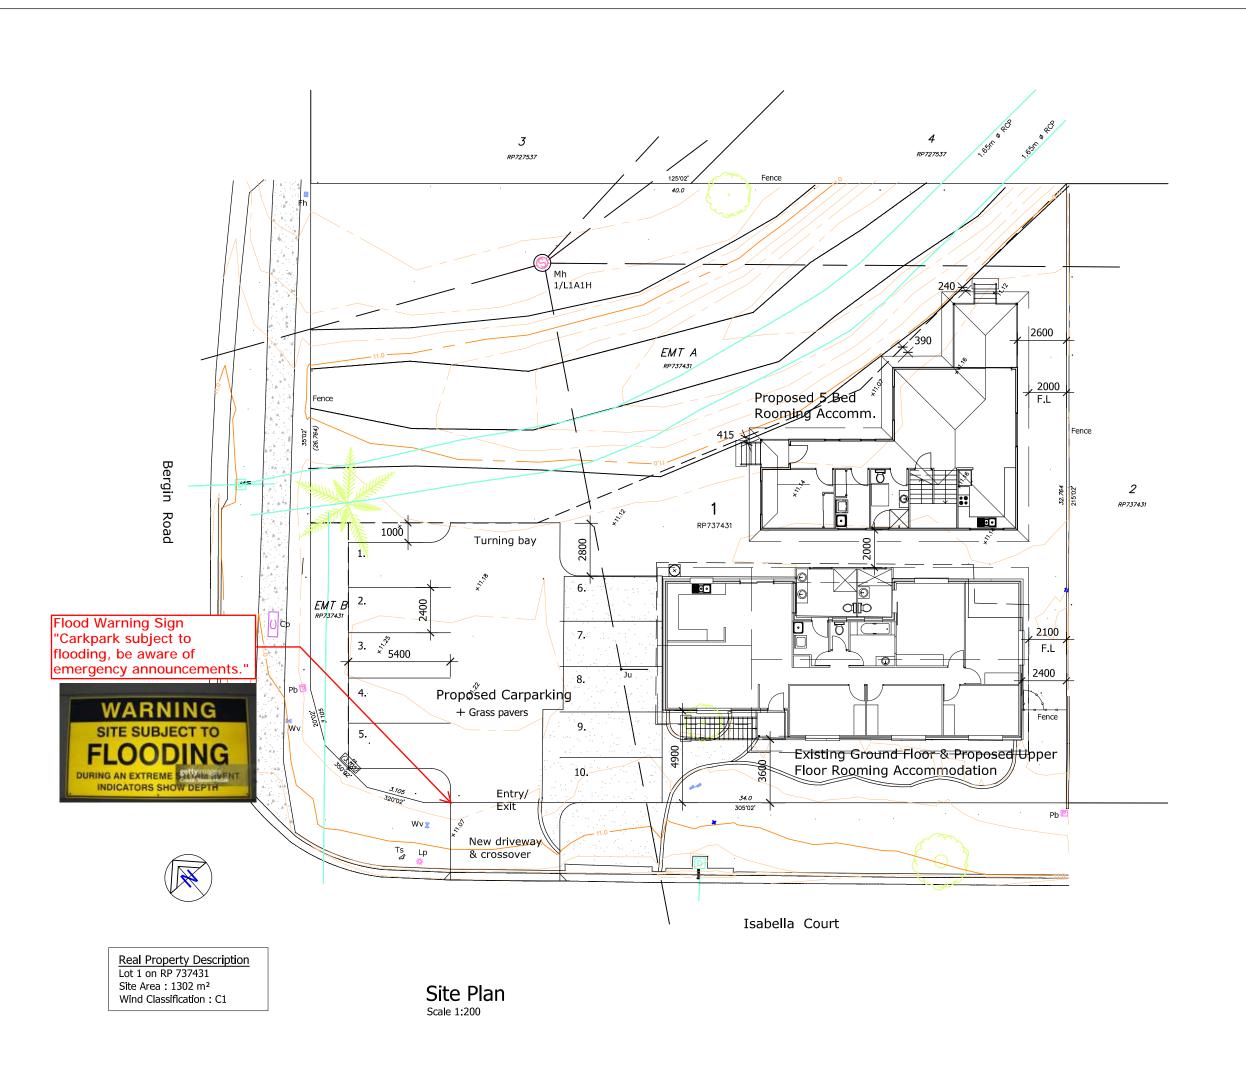

General Notes

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С	Request Items 1,2 & 4 TCC Planning	08/05/25
В	Floor Level Raised to 900mm	17/02/25
А	Preliminary Design	24/09/24
No.	Revision/Issue	Date



Gery Benson BSc. Dip Arch Draft.


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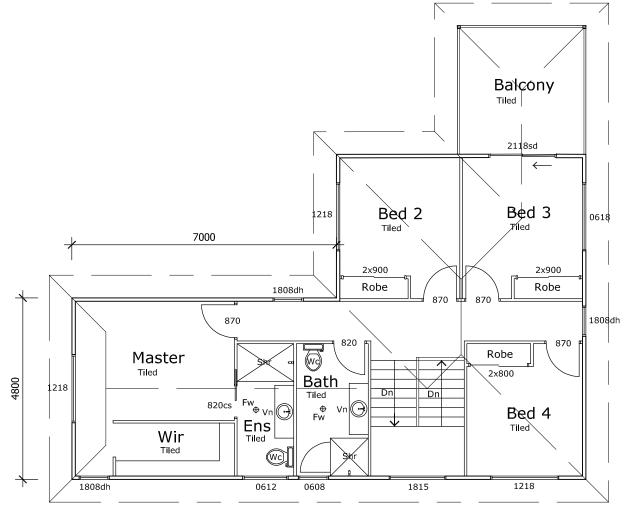
QBCC Lic. No. 1256424 ABN 68 537 687 613 Emall : plans@bensonbulldIngdesIgns.com.au www.bensonbulldIngdesIgns.com.au

Project Name and Address Proposed Rooming Accomm.

Development Abel Family Trust Pl 94 Bergin Road, Cranbrook, Queensland

Project No. 2024-12	Dwg No. DD01	Issue C
Date March, 2024	Designed G.B	
Scale 1:200 @ A3	Drawn G.B	



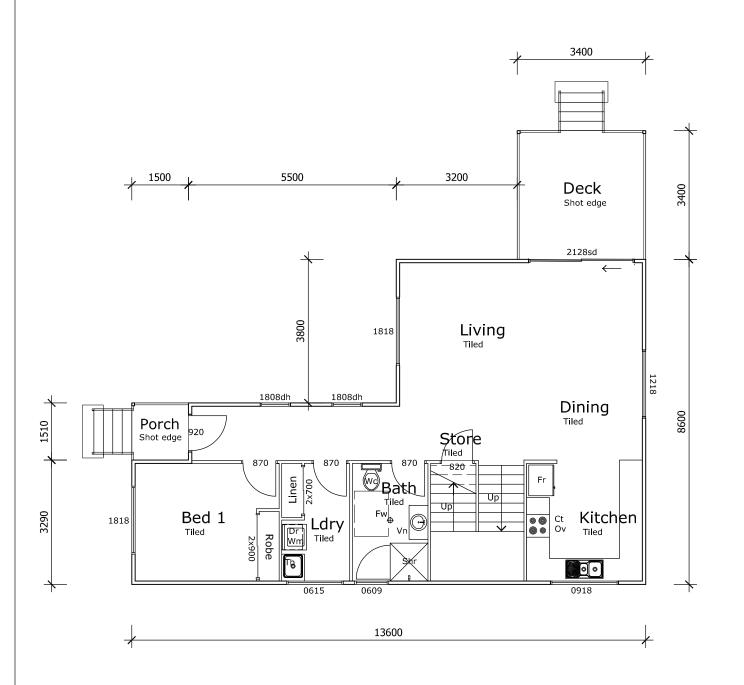

Ground Floor Plan Scale 1:100

Floor Areas Living: 88.25 m² Patio: 11.56 m² Porch: 2.10m² Overall: 101.92 m²

Upper Floor Plan
Scale 1:100

Living: 90.36 m² Balcony: 11.56m² Overall: 101.92 m²

Floor Areas

General Notes

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С	Request Items 1,2 & 4 TCC Planning	08/05/25
В	Floor Level Raised to 900mm	17/02/25
Α	Preliminary Design	24/09/24
No.	Revision/Issue	Date



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Project Name and Address

Proposed Rooming Accomm. Development Abel Family Trust Pl 94 Bergin Road,


Cranbrook, Queensland

Project No. 2024-12	Dwg No. DD02	Issue C
Date March, 2024	Designed G.B	
Scale 1:100 @ A3	Drawn G.B	



North West Elevation

Scale 1:100

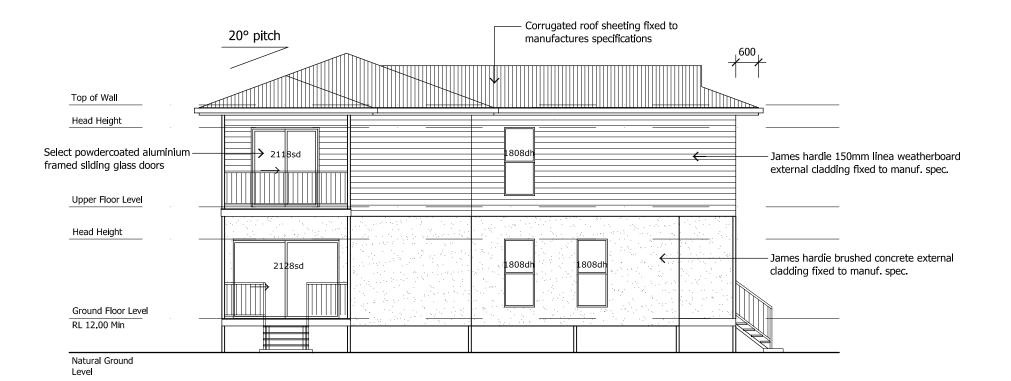

North East Elevation

Scale 1:100

Document Set ID: 27483461 Version: 1, Version Date: 27/08/2025 General Notes

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А	Preliminary Design	24/09/24
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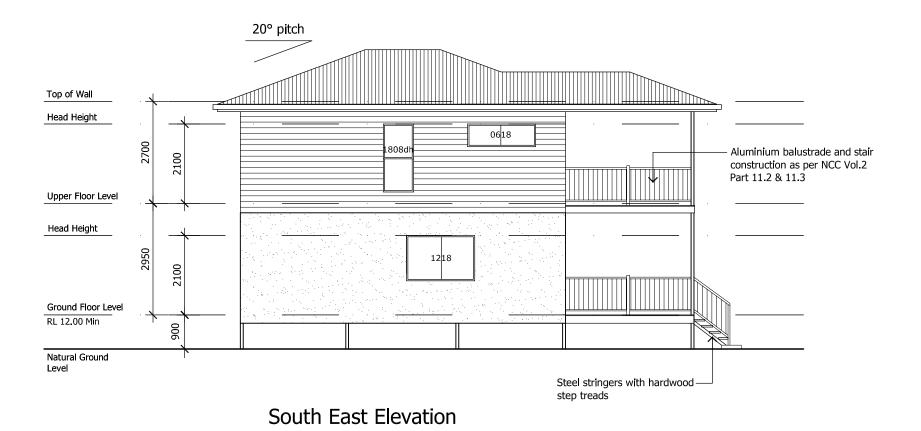
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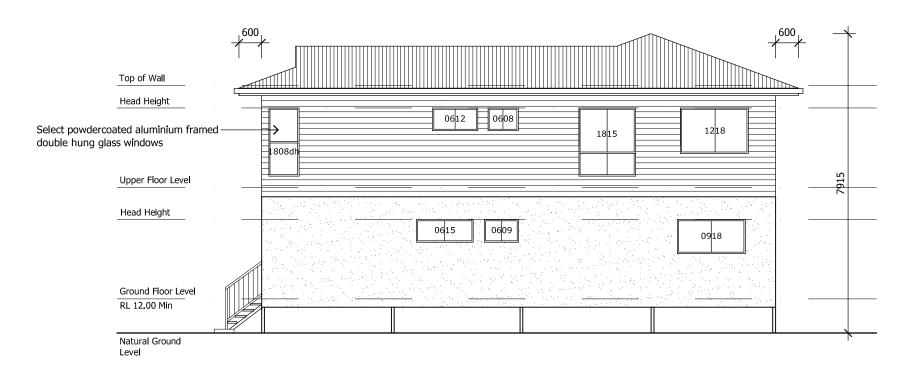
Project Name and Address

Proposed Rooming Accomm. Development Abel Family Trust Pl

94 Bergin Road, Cranbrook, Queensland

Project No. 2024-12	Dwg No. DD03	Issue C
Date March, 2024	Designed G.B	
Scale 1:100 @ A3	Drawn G.B	





South West Elevation

Scale 1:100

General Notes

- General Notes

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С		
	Request Items 1,2 & 4 TCC Planning	08/05/25
В	Floor Level Raised to 900mm	17/02/25
А	Preliminary Design	24/09/24
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Call: 0416 936 452


QBCC Lic. No. 1256424 ABN 68 537 687 613 Emall : plans@bensonbulldIngdeslgns.com.au www.bensonbulldIngdeslgns.com.au

Project Name and Address

Proposed Rooming Accomm. Development Abel Family Trust Pl 94 Bergin Road,

Cranbrook, Queensland

Project No. 2024-12	Dwg No. DD04	Issue C
Date March, 2024	Designed G.B	
Scale 1:100 @ A3	Drawn G.B	

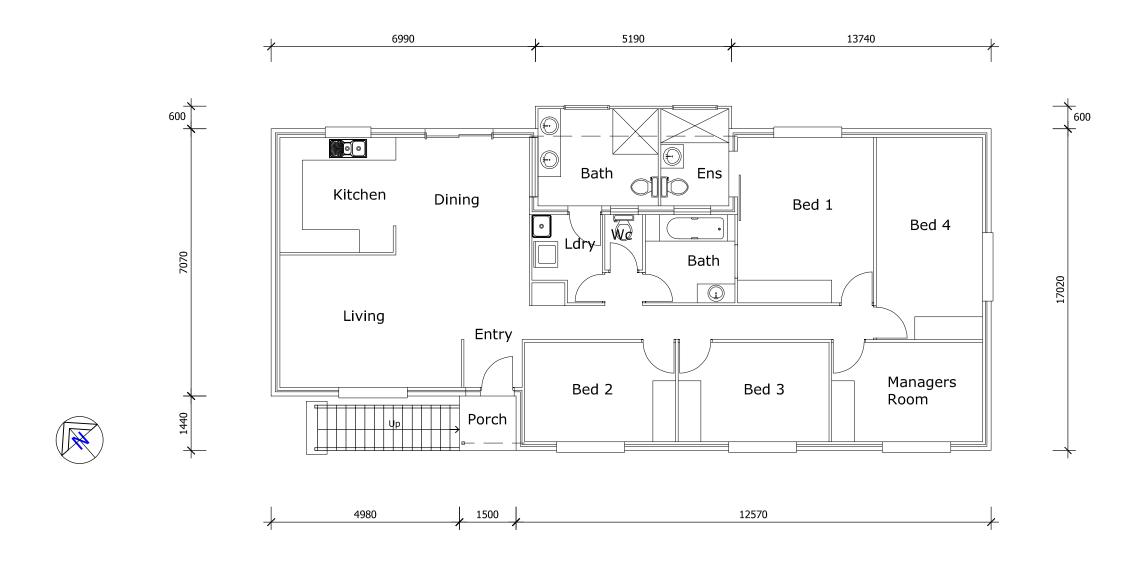

Floor Areas Living: 155.90 m² Porch: 2.16m² Overall: 158.06 m²

Existing Ground Floor Plan

Scale 1:100

General Notes

- General Notes

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А	Preliminary Design	24/09/24
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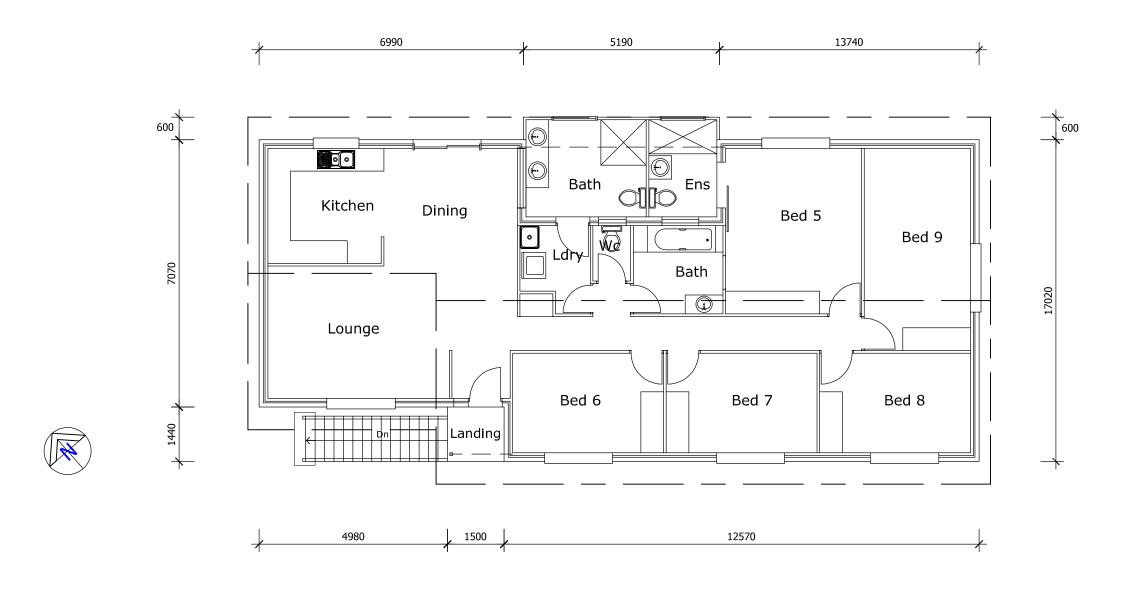
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Project Name and Address

Proposed Rooming Accomm. Development Abel Family Trust Pl 94 Bergin Road, Cranbrook, Queensland

Project No. 2024-12	Dwg No. DD05	Issue B
Date March, 2024	Designed G.B	
Scale 1:100 @ A3	Drawn G.B	



Floor Areas Living: 155.90 m² Landing: 2.16m² Overall: 158.06 m²

Proposed Upper Floor Plan Scale 1:100

General Notes

- General Notes

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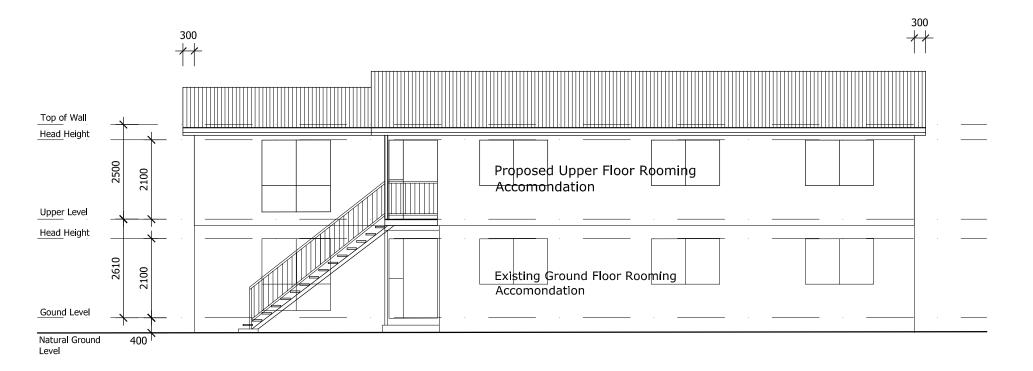
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Project Name and Address


Proposed Rooming Accomm. Development Abel Family Trust Pl 94 Bergin Road, Cranbrook, Queensland

Project No. 2024-12	Dwg No. DD06	Issue B
Date March, 2024	Designed G.B	
Scale 1:100 @ A3	Drawn G.B	



South West Elevation

Scale 1:100

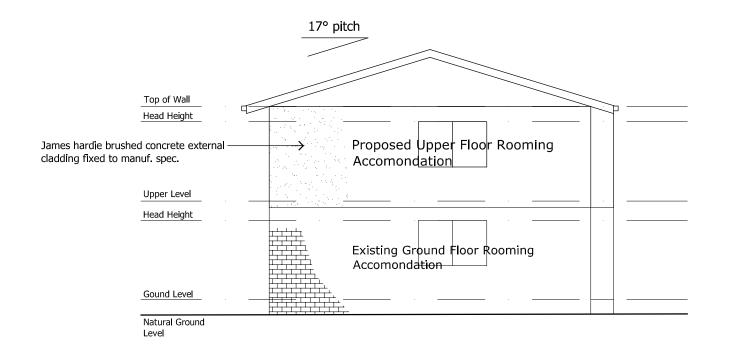

South East Elevation

Scale 1:100

Document Set ID: 27483461 Version: 1, Version Date: 27/08/2025 General Notes

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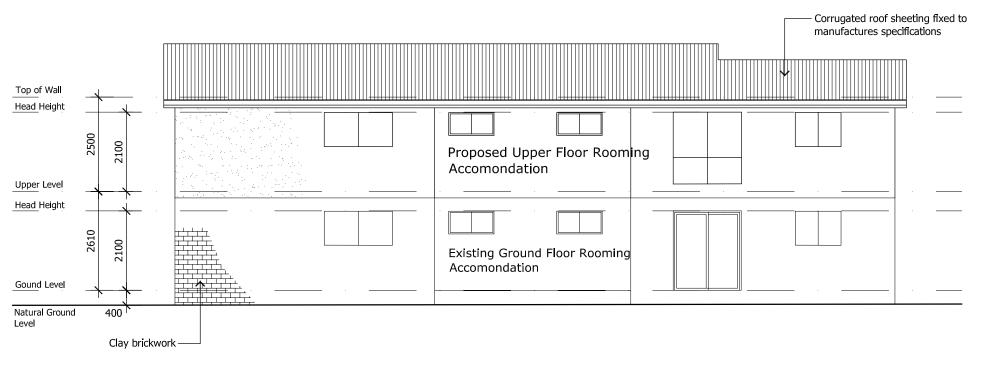
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Project Name and Address

Proposed Rooming Accomm. Development Abel Family Trust Pl


94 Bergin Road, Cranbrook, Queensland

Project No. 2024-12	Dwg No. DD07	Issue B
Date March, 2024	Designed G.B	
Scale 1:100 @ A3	Drawn G.B	



North East Elevation

Scale 1:100

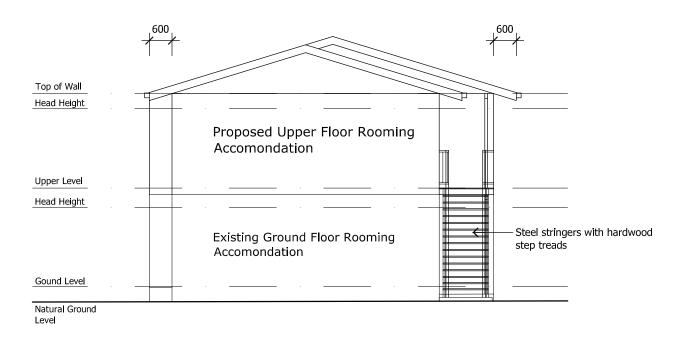

North West Elevation

Scale 1:100

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Project Name and Address

Proposed Rooming Accomm. Development Abel Family Trust Pl

94 Bergin Road, Cranbrook, Queensland

Project No. 2024-12	Dwg No. DD08	Issue B
Date March, 2024	Designed G.B	
Scale 1:100 @ A3	Drawn G.B	

APPENDIX 3

EMERGENCY EVACUATION PLAN

Emergency Evacuation Plan

94 Bergin Street Cranbrook QLD 4814

THIS SITE IS IDENTIFIED AS AT RISK OF INUNDATION IN THE TOWNSVILLE CITY COUNCIL
MODELLED FLOOD STUDY AREAS

SIGNIFICANT INUNDATION IS PREDICTED TO OCCUR DURING A 1 IN 50 YEAR (2% AEP)
RAIN EVENT OR GREATER

WHEN ADVISED TO EVACUATE - EVACUATE AND SHELTER IN A SAFER PLACE

Flood Hazard

This property (94 Bergin Road, CRANBROOK QLD 4814) is identified as **subject to flooding** during a 1% AEP Flood event (1 in 100-year event) (Figure 1). Water depth within the property may be up to 0.8m deep. Water depth across the Bergin Road/ Isabella Court intersection and property access may be 1.0m deep.

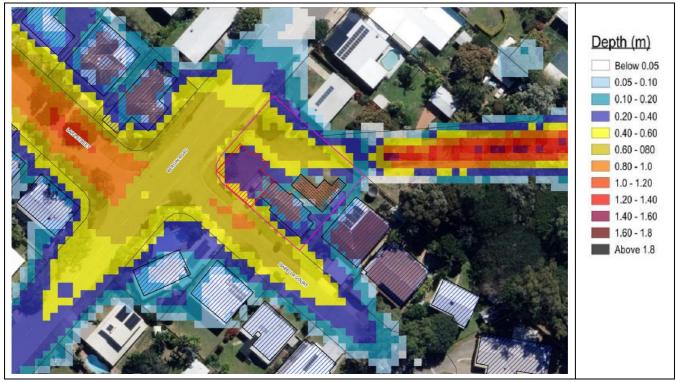


Figure 1 Site Specific Assessment Identifying 1% AEP Developed Flood Hazard – Northern Consulting Engineers, Report Ref BNC0091/02:IG, Map D02, 05/06/2025

This Emergency Evacuation Plan is intended to advise you of the risk associated with the land at 94 Bergin Road, Cranbrook Qld 4814

It is impossible to predict or pre-empt the range of situations that may present at a location over time. This document is designed to advise you of the relevant resources available to you and encourage you to work through the process of evaluating your risk and establishing your own evacuation plan suitable to your situation and circumstances.

VICTORIA (Bairnsdale) PO Box 1288, Bairnsdale, 3875 03 5153 1744

ECOSYSTEMS MANAGEMENT (AUST) PTY LTD
ACN: 665 541 953

QUEENSLAND (Townsville) PO Box 721, Deeragun, 4818 07 4454 1744

Technological Solutions for Sustainable Natural Resource Management

Preparation

You must be prepared for flooding to occur at this property, and for access to this property to be isolated in the event of storm tide flooding impacting the Townsville area. This includes preparing an Emergency Kit for sheltering in place and an Evacuation Kit.

Shelter in Place or Evacuate

You must decide the conditions under which you will shelter in place or choose to evacuate. You must identify the trigger point for this. There is no right or wrong answer to this, except that you must be capable of executing your plan without assistance from emergency services. You must consider evacuating before available access roads become inundated.

If you are instructed to evacuate by the Disaster Management Group or Emergency Services YOU MUST EVACUATE.

If you are a vulnerable member of society (you have family member with special needs, are aged, immobile, or otherwise reliant on self-care intervention by a family member or service provider) you must consider evacuation your only option.

If you plan to shelter in place, you must be satisfied that you will be able to manage your safety and that of any dependants, for the duration of inundation or isolation at the property. This includes provision of food and water for at least one (1) week for all occupants sheltering in the premises, backup power generator (and sufficient fuel) to operate a refrigerator, and other essential items. Consider that electricity will be unavailable during and in the immediate days after the storm event for network maintenance and public safety reasons.

Do not shelter in place with the fall-back plan that you can be rescued by emergency services.

Sheltering in place is <u>not</u> a last resort – it must be planned and only considered if all persons staying at the property are able bodied and capable of undertaking the necessary actions required to maintain a level of safety at the property. If you cannot satisfy these requirements, you must consider evacuation as your only option.

Evacuation centres are provided with the minimum requirements to provide basic shelter during an evacuation event. They are not designed for long term or post event temporary accommodation. Preparation of a comprehensive evacuation plan and taking responsibility for your own safety will ease the burden on resources and allow dedication of resources to help those most in need.

Work through the tables below – identify options suitable to your situation.

Review:

Townsville Storm Tide Evacuation Guide. Accessible online:

https://www.townsville.qld.gov.au/ data/assets/pdf file/0021/6735/TCC Evacuation-Guide.pdf

Townsville Local Disaster Management Group. Townsville Emergency Action Guide. Accessible online: https://www.townsville.qld.gov.au/ data/assets/pdf file/0027/76572/TCC Emergency-Action-Guide 110321.pdf

Evacuation Plan

Identify:		Notes / Details
Where will you evacuate to: How long will you need to stay?	Townsville Evacuation Centre (Heatley State School)	No pets accepted. Limited facilities for long term evacuation.
Do you need to bring additional bedding, clothing, food, other supplies or resources?	Friends/relatives house in non- flood prone area:	Address Phone number
Consider that general supply of goods and services can be interrupted by a significant flood event impacting the Townsville or north Queensland	Motel or caravan park accommodation in non-flood prone area Are they Pet friendly?	Address Phone number
landscape.	Other Location	Address Phone number
What will you do with Pets? Ensure you provide adequate food	Boarding Kennels/ Cattery	Address Phone number
supply, carrier / leash etc. Registration details (tag /microchip) Take a current photo of your pets on	Friends/ relatives house	Address Phone number
your phone. Any medications your pet requires.	Leave in a safe place on the property (above the level of flood water) Not advised in extreme weather conditions	Address Phone number
Additional Vehicles	Friend/ relative house	Address
Your second car / caravan / trailer / lawn mower may need a temporary second		Phone number
home	Commercial Storage facility	Address Phone number
	Suitable open space in non-flood prone area	Address Phone number
Communications You must tell someone of your situation	Close relative (parent, sibling)	Name Address
and your plans. Is anyone staying to shelter in place – how many people and what resources do		Phone number Email
they have? Who is evacuating and where are they	Friend / work colleague	Name Address
going? **If you are concerned about looting, do not make public posts on social media		Phone number Email
	Disaster Management Group / Emergency Services notification/registration for evacuees	Name Address Phone number Email

Evacuation Kit

Identify:			Notes / Details
Where are your important Documents/ valuables?	Passport		YES / NO
Store in a zip lock bag or other water	Wallet/purse and its contents		YES / NO
proof container	Medical prescriptions	YES / NO	
Will you store some items in high cupboards above flood level or take	Birth / Death / Marriage / citizenship Certificates	YES / NO	
them all with you? Add additional items as required.	Photograph Albums		YES / NO
Take a copy of this plan with you	Will / power of attorney documentation		YES / NO
	Pension / welfare cards/ other important documentation		YES / NO
	Insurance documents / vehicle registration documents		YES / NO
	Jewellery or other valuables (military medals etc)		YES / NO
	Cash / Car keys/fobs / house keys/ work keys etc		YES / NO
Medications / dietary requirements Evacuation centres are not equipped	Prescription / pharmacy only medications		
with medical equipment other than basic first aid.	Dietary supplements / baby formula/ gluten/ allergen free food/snacks for up to 48 hours.		
Special dietary requirements are not catered for – if you have specific allergies or intolerances, you should have some snack food as a minimum to last up to 2 days.	Medical equipment (CPAP machine / breast pump/bottles/ personal sanitary items/ basic toiletries) **Baby wipes / personal care wipes are recommended to include in evacuation kits in the absence of being able to shower or bath		
Clothing/ Linen	Change of clothing and underwear for minimum 3 days. Infants and small children may require more. Disposable nappies (even if you use cloth normally – there will not be adequate facilities to launder these items). Other linen – towels, baby essentials, pillows etc		
Communications and administration tools Most emergency management services and recovery support agencies and services are provided in an online environment. Take your mobile phone, laptop and chargers with you.	Mobile phones/tablets/ laptops/ chargers Portable battery banks can provide up to 2 or 3 full recharges for a mobile phone – consider putting one in your evacuation kit.		

Make a checklist that you can review every year before the storm season starts.

Make a date with your calendar to review your Evacuation Plan and your Evacuation Kit.

Make sure it has everything that is on the list.

Ask yourself if you still need that item or if there is something different you need this year!

Evacuation Route

Plan your evacuation route — any road that is trafficable and open to public traffic can form part of your evacuation route. The best route will be dictated by the location of your evacuation site. The attached map shows the most direct route to the Heatley Evacuation Centre (using arterial roads in the local road network). Evacuation routes indicated by Townsville City Council evacuation guides are shown in Yellow. These are major roads, with multiple lanes and most are not located in areas of deep inundation.

Evacuation Routes are shown as a guide only – **do not** drive through flood water.

If it is flooded - Forget it. Evacuate before the roads become flooded.

The Evacuation Plan Map attached identifies the most direct routes away from the property to the Heatley Evacuation Centre, the Townsville CBD and the Townsville Ring Road which provides highway access to the north and south of Townsville.

These roads are not guaranteed to be free from flooding – once a road is under water it is no longer a safe potential evacuation route – it is important to make the decision to evacuate before the roads become un-trafficable.

Consider heavy traffic impacting your ability to reach your destination. Make sure you allow enough time to arrive before the roads become un-trafficable.

Monitor Townsville Disaster Management Dashboard and the Department of Main Roads mobile app for road conditions and road closures.

Secure Your Property

Before you leave your property, ensure the following:

- Lock doors
- Turn off power, gas, and water
- Take your Evacuation and Emergency Kits

Further information (from Townsville Emergency Action Guide):

During emergencies, the Townsville LDMG is your official source of information.

Visit Council's website for digital copies of local emergency management plans, action guides, mapping and evacuation information:

disaster.townsville.qld.gov.au townsville.qld.gov.au

'Follow' Townsville City Council's Townsville Disaster Information Facebook page for up to date information provided directly from the Townsville LDMG:

Townsville Disaster Information

Log on to the Bureau of Meteorology website for weather updates, warnings and information:

bom.gov.au

ABC TV and Radio are the official emergency news channels.

Watch and listen for emergency updates.

Tune your radio to your local radio station:

ABC North QLD 630 AM Triple M 102.3FM Hit FM 103.1FM Power100 100.7FM Star 106.3 FM 103.9FM Triple T 4K1G 107.1FM Live FM 99.9FM

Further information on preparing, emergency alerts and information can be accessed at:

disaster.qld.gov.au qldalert.com

Context and Justification

Flood Impact Assessment

Northern Consulting Engineers (NCE) have prepared a flood impact assessment for this site, pertinent to the development application for rooming accommodation (reference: BNC0091/02:IG).

The flood model identifies that a storm tide event of 20% AEP or greater (20% to 1% AEP) will result in inundation of the Bergin Road / Isabella Court intersection, being primary access to the property, of 0.2 to 0.4m depth or greater. A 5% AEP storm tide event will result in minor inundation in the property's carpark (up to 0.2m) and increased flooding of the Bergin Road / Isabella Court intersection (0.6m). At this height, the intersection is not trafficable for small cars. The 1% AEP storm tide event results in more extensive flooding of the carpark and intersection, restricting access to and from the property for small vehicles, and limiting safe or practical access for larger vehicles. Water velocity at this depth exceeds 0.3m/second. The Bergin Road / Isabella Court intersection reaches Hazard Class 3 (unsafe for small vehicles and vulnerable occupants, likely to isolate residents) during a 1% AEP storm tide related flooding event.

Flood duration may be as short as a couple of hours, however with significant storm events (such as cyclones or tropical monsoon rainfall events), the duration of flooding and inundation may last for several days.

Appropriate building design, with floor levels at lease 300mm above modelled flood levels, should ensure that the residences are safe to shelter in place with adequate planning. Vulnerable persons should consider that sheltering in place with limited access is not their safest option if they are likely to require additional support or medical attention.

Primary access is identified by NCE as along Alice Street to Ross River Road. This intersection is controlled by signals ensure safe egress during high traffic flows. Alice Street becomes inundated near the Ross River Road to a minor degree during a 1% AEP storm tide event. Evacuation must be completed prior to flood levels reaching peak levels. Lara Street should be avoided as an evacuation route – it becomes inundated along with the Bergin Road / Isabella Court intersection.

Emergency Management Planning

Emergency Management in Queensland is managed using the PPRR Framework (QFES,2017):

Prevention Preparedness Response Recovery

In the context of flooding, little can be done in terms of Prevention, particularly in older areas that were developed before planning and development controls considered flood risk to any great extent. The hazard is identified; therefore, risk mitigation must be the next step.

This plan addresses the Preparedness component of flood risk at this location to the extent practical. It is incumbent on all persons to take a degree of responsibility for their own safety, thus working through the process of forward planning is a necessary step towards fulfilling that obligation.

The Response phase of an event impacting this location is to enact this plan, with the intention of avoiding the need for emergency services assistance either for evacuation or for resupply if sheltering in place.

Recovery comes after the emergency is over, and can be described simply as the process of returning to normal operations.

Development Assessment

The Development Application for **Development Permit – Material Change of Use (MCU25/0011) Lot Creation 1 into 2** was assessed and subject to a stop of the current assessment period as of 25 August 2022.

Application Details

Application no: MCU25/001
Assessment no: 3027001

Proposal: Rooming Accommodation

Development Type:Development Permit - Material Change of UseStreet address:94 Bergin Road CRANBROOK QLD 4814

Real property descriptions: Lot 1 RP 737431
Assessment benchmarks: Planning Act 2016

Planning Regulation 2017 State Planning Policy

North Queensland Regional Plan

Townsville City Plan

Level of assessment Assessable development - Impact assessment

Responsibility

This Development Assessment approves the use of the property for rooming accommodation. It is the responsibility of the operator of the rooming accommodation to ensure that every tenant/ resident is provided with a copy of this evacuation plan, and that every tenant/resident independently makes their own evacuation plan and prepares their own Emergency and Evacuation Kits, consistent with the advice issued by the Local Disaster Management Group and Townsville City Council. Notices regarding this requirement should be visible within the common areas of the rooming accommodation, consistent with requirements for notification of other essential safety measures.

Resources

QPS, 2024. Interim Queensland Prevention, preparedness, Response and Recovery Disaster Management Guideline. Queensland Fire and Emergency Services, State of Queensland, 2017. URL:

https://www.townsville.qld.gov.au/ data/assets/pdf file/0027/76572/TCC Emergency-Action-Guide 110321.pdf

Townsville City Council. Townsville MAPS Flooding thematic map. Accessed on 2nd November 2022. Accessible online: https://maps.townsville.qld.gov.au/Mapping/index.html?viewer=TownsvilleMAPS Flooding.Mapping

Townsville Local Disaster Management Group. Townsville Emergency Action Guide. Accessible online: https://www.townsville.qld.gov.au/ data/assets/pdf file/0027/76572/TCC Emergency-Action-Guide 110321.pdf

SUITABLY QUALIFIED PERSON

This document has been prepared by a Suitably Qualified Person according to the definitions in the EP Act 1994. I hold a Bachelor of Environmental Science (Management), Graduate Diploma in Bushfire Protection and have over 20 years' experience in environmental management and emergency management planning. All information presented in this report is believed to be true, correct and complete. The document addresses the requirements described by the regulatory authority, and all opinions expressed are honest and reasonable.

Marcia Griebenow BEnvSc GradDip (Bushfire Protection) MEIANZ

M A N A G E M E N T


LIMITATION AND DISCLAIMER.

Maria Guibena

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EVACUATION PLAN THIS SITE IS IDENTIFIED AS A ORANGE (VERY HIGH) RISK OF INDUNDATION IN A FLOOD OR STORM TIDE INUNDATION IS PREDICTED TO OCCUR AT 1.0m ABOVE HIGHEST ASTRONOMICAL TIDE (HAT). 94 BERGIN ROAD, CRANBROOK (1RP737431) WHEN ADVISED TO EVACUATE Limitation & Disclaimer: Data presented is for information only, and is not to be used for navigation. **EVACUATE AND SHELTER IN A SAFER PLACE** No liability is accepted for use outside of the intended purpose. REFER TO THE TOWNVILLE EMERGENCY ACTION GUIDE Follow the advice of the Townsville Disaster Management Group or Emergency Services at all times. Monitor the Disaster Management Dashboard for flood notifications Follow the advice and checklists in the Legend TOWNSVILLE EMERGENCY ACTION GUIDE Detail 219050 Flood - Page 35 to page 37 Direct Route to CBD Heatley Public Cyclone Shelter 321 Fulham Road, Heatley **EVACUATE** Direct Route to Heatley Public Cyclone Shelter (see page 26 to 34 of TCC Emergency Action Guide for evacuation When warnings reach your predetermined trigger OR Major Roads / Highways when advised by authorities Local Roads routes) DO NOT DELAY Direct Route to Townsville Ring Road -TCC Evacuation Routes Access to the North or South 500 250 Coordinate System: GDA 1994 MGA Zone 55



This guide is used to inform residents of predicted storm tide inundation associated with a tropical cyclone.

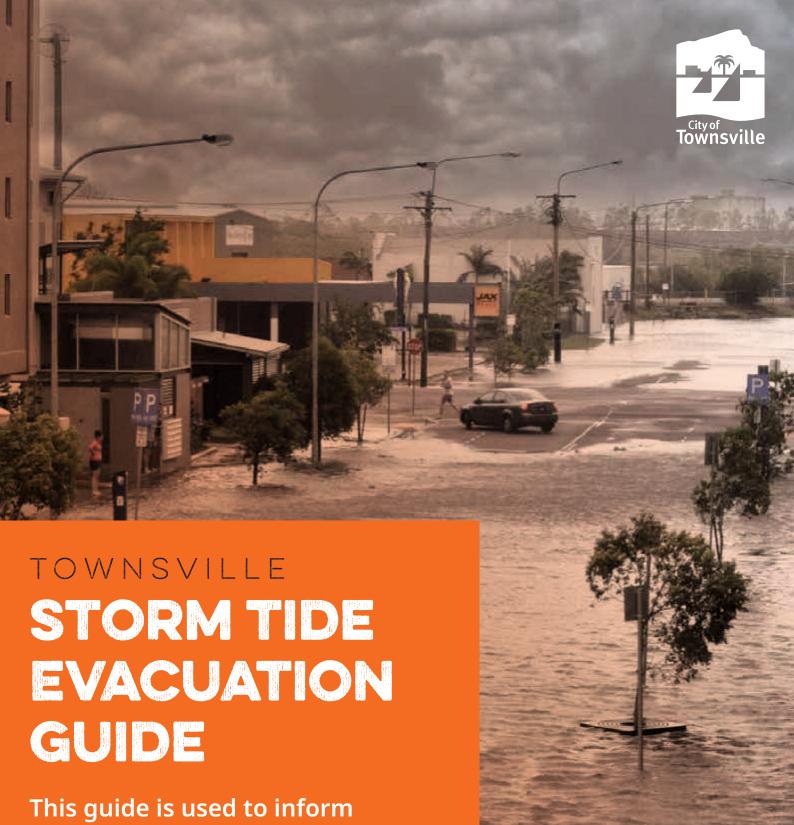townsville.qld.gov.au





MESSAGE FROM THE MAYOR

North Queensland is one of the most cyclone-prone areas in Australia. Like many of our neighbouring coastal communities, natural disasters are a price Townsville residents pay for living in paradise.

Along the coast, storm tides can occur as a result of a cyclone. Cyclone threats in our region could result in an evacuation of particular areas in our city. We will only order an evacuation if a storm tide threatens to inundate developed areas.

This Storm Tide Evacuation Guide is to help you, as a resident, prepare for cyclone events that result in an evacuation. If you are not required to evacuate, your home is often the safest place for you. Before a cyclone event you will need to make sure that you are secure in your home. If you feel you are not secure in your home please make alternative arrangements with friends and family.

If you are told you have to evacuate, you should make your way to family or friends outside the threatened zone. Townsville's Local Disaster Management Group has shelters available for community members who have no other alternative. Remember that these shelters are intended for use by those identified as being in the storm tide area. Shelters unfortunately do not have the capacity to cater for people with special needs; and there are no support services such as bedding, food, drink or material aid.

I urge you to read the information provided in this booklet, view the detailed 'by suburb' maps on Council's website and understand the evacuation procedures. In the event of a cyclone or storm tide, take immediate action by following the checklists included in this booklet.

Regards,

Jenny Hill

WHAT IS A STORM TIDE?


A storm tide is a rise above the tidal water level along a shore that is associated with a tropical cyclone. Storm tides will be accompanied by gale force winds, with successive waves of seawater rapidly moving across the foreshore.


When a cyclone forms over open waters the strong winds pushing the water, combined with the low atmospheric pressure in the eye of the cyclone cause the level of the sea to rise, which results in the formation of large waves.

If this happens away from land, the water can escape and move freely away from the building storm. As the cyclone moves towards land and the depth of the water becomes shallower, the ever-increasing wall of water does not have a chance to flow away. These waves may inundate land and cause destructive damage to anything in its path. Trees, building material and other debris may be carried along by the storm tide. Any evacuation must occur prior to the storm tide event.

Please note that inundation by storm tide is not comparable with riverine flooding.

A storm tide event should not be confused with a tsunami. A tsunami is a series of waves generated by a sudden upward movement of the ocean floor, normally due to earthquakes and is NOT related to a cyclonic event.

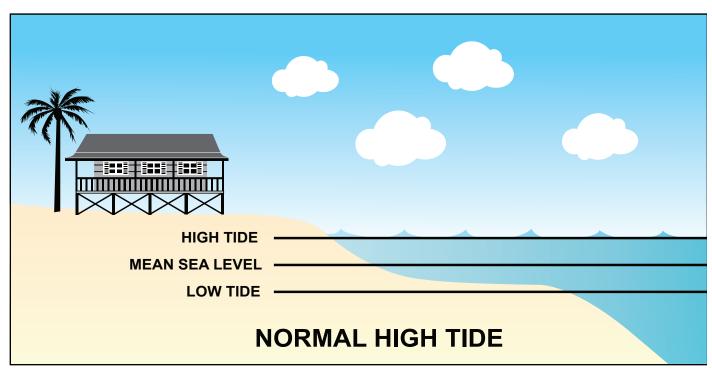

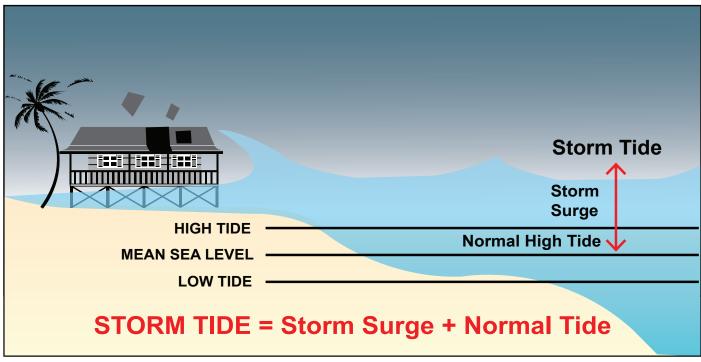

WHAT IS A CYCLONE?

A tropical cyclone is a violent collection of whirling winds and dense cloud mass. Winds spiral clockwise around a central eye of exceptionally low pressure. With winds reaching speeds in excess of 200km/h, cyclones can be extremely dangerous.

WHAT ARE CYCLONE CATEGORIES?

The severity of a tropical cyclone is measured by a category determined by the Bureau of Meteorology (BOM).

Cyclone categories range from 1 for weaker cyclones to 5 for the most severe cyclones. This helps the community assess the severity of the cyclone and take appropriate actions.

The category of a cyclone refers to the severity of winds in a maximum wind zone. You may not experience the effects of the maximum winds. Damage experienced may vary according to location factors.

N.B. The category of a cyclone does not refer to an associated storm tide. Warnings for a storm tide will be issued separately by the Bureau of Meteorology.

CATEGORY	CLASSIFICATION	STRONGEST GUST (KM/H)	TYPICAL EFFECTS
1	Tropical cyclone	90–125 km/h Gales	Minimal house damage. Damage to some crops, trees and caravans. Boats may drag moorings.
2	Tropical cyclone	125-164 km/h Destructive winds	Minor house damage. Significant damage to signs, trees and caravans. Heavy damage to some crops. Risk of power failure. Small boats may break moorings.
3	Severe tropical cyclone	165-224 km/h Very destructive winds	Some roof and structural damage. Some caravans destroyed. Power failure likely.
4	Severe tropical cyclone	225–279 km/h Very destructive winds	Significant roofing and structural damage. Many caravans destroyed and blown away. Dangerous airborne debris. Widespread power failures.
5	Severe tropical cyclone	More than 280 km/h Extremely destructive winds	Extremely dangerous with widespread destruction



CYCLONE WATCH

A cyclone watch is issued at six (6) hourly intervals if a cyclone or potential cyclone exists, and there is a likelihood gale force winds or stronger will affect coastal or island communities within the next 24 to 48 hours.

Cyclone Warning

A cyclone warning is issued at three (3) hourly intervals if gale force winds or stronger are expected to affect coastal or island communities within the next 24 hours. Warnings are updated **every hour** when a cyclone is close to landfall. The Standard Emergency Warning Signal (SEWS) may be used with some cyclone warnings.

Severe Weather Warning

A severe weather warning may be issued if the system is no longer a cyclone but communities are still being threatened by damaging winds, flooding rains or pounding seas.

HOW TO USE THIS GUIDE

This Storm Tide Evacuation Guide was developed to assist residents in determining if their properties are at risk of inundation from a storm tide.

As a local resident, Council recommends that you:

- 1. Review the evacuation maps in this guide and identify the location of your property. **Visit Council's** website to view more detailed mapping, with evacuation zones depicted by street and suburb.
- 2. Consider the tips contained in this guide for preparing a household emergency plan and emergency kit.
- 3. Familiarise yourself with the local emergency contact details and radio station information.

If your residence is located in a coloured evacuation zone, your property may be inundated in a storm tide event. The height of the predicted storm tide during the disaster event will determine which zones will be affected.

N.B. – If you are <u>not</u> located in a coloured evacuation zone, your suburb will not be shown on the detailed maps located on Council's website.

EVACUATION ZONES

5V4 6U 477 6W 7 6W 5		LEVEL OF INUNDATION		
EVACUATION ZONE	RISK OF INUNDATION	METRES ABOVE HAT	METRES ABOVE AHD	
Red	Extreme	1.0m	Less than 3.0m	
Orange	High	2.0m	3.0m - 4.0m	
Yellow	Medium	2.0m - 4.0m	4.0m - 6.0m	
Blue	Low	4.0m and above	6.0m – 8.0m	

WHAT IS HAT?

HAT stands for Highest Astronomical Tide, which is comparable to a king tide. It is the highest level of water, which can be predicted to occur under any combination of astronomical conditions. BOM advices regarding storm tide will refer to a height (in metres) above HAT. Council will use this BOM information to advise which zones may be affected.

WHAT IS AHD?

AHD stands for Australian Height Datum, which is the altitude measurement for land-based mapping. In 1971, mean sea level was assigned the value of 0.000m elevation based on observations recorded by thirty tide gauges around the coast of Australia for the period 1966–1968. The resulting datum surface, with minor modifications in two (2) metropolitan areas, has been termed the Australian Height Datum (AHD) and was adopted by the National Mapping Council in 1971 as the datum to which all vertical control mapping is to be referred. Elevations quoted using this datum are normally followed with the acronym (AHD).

WHAT IF I AM IN AN EVACUATION ZONE?

1. Prepare a documented household emergency plan.

EMERGENCY PLAN ACTIVATION				
☐ Contact all householders		Tune into warnings		Check on neighbours
☐ Shelter in our strongest room		Locate Emergency Kit		Make final preparations
EVACUATION DESTINATION				
Place to meet:		Address:		
Phone number:		Email address:		
OUT OF TOWN EMERGENCY CONT	ACT			
Name:		Address:		
Phone number:		Email address:		
MAIN SERVICE SUPPLIES LOCATION	DΝ	SWITCH OFF		
Electricity:		□ Yes □ N	No	
Gas:		□ Yes □ N	No	
Water:		□ Yes □ N	Vo	
VEHICLE REGISTRATION		OUR STRONGEST	ROC	OM IS
VEHICLE REGISTRATION		OUR STRONGEST	ROC	OM IS
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		Description:	ROC	OM IS
PETS			ROC	OM IS
PETS Name:		Description:	ROC	OM IS
PETS Name: Name:		Description:	ROC	OM IS
PETS Name: Name: EVACUATION CHECKLIST Prior to evacuation: □ Ensure vehicle is full of fuel		Description: Description:	red ev	acuation routes
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PETS Name: Name: EVACUATION CHECKLIST Prior to evacuation: □ Ensure vehicle is full of fuel		Description: Description:	red ev	acuation routes
PETS Name: Name: EVACUATION CHECKLIST Prior to evacuation: □ Ensure vehicle is full of fuel □ Ensure you have cash on hand When evacuating: □ Pack Emergency Kit, and a copy of co	pur	Description: Description: Market State Description: Market State Description: Market State Description: Market State Description: Descripti	red ev n of o	acuation routes ur evacuation place for power, gas and water
PETS Name: Name: EVACUATION CHECKLIST Prior to evacuation: □ Ensure vehicle is full of fuel □ Ensure you have cash on hand When evacuating:		Description: Description: Manage of the security of the secur	red ev n of o upply	acuation routes ur evacuation place for power, gas and water ome and proceed to our
PETS Name: Name: EVACUATION CHECKLIST Prior to evacuation: □ Ensure vehicle is full of fuel □ Ensure you have cash on hand When evacuating: □ Pack Emergency Kit, and a copy of comergency Plan	con	Description: Description: Manage of the security of the secur	red ev n of o upply	acuation routes ur evacuation place for power, gas and water ome and proceed to our





2. Prepare an emergency kit.

Special Items	In a waterproof wallet
☐ Baby needs such as nappies and bottles	☐ Will and insurance policies
☐ Medication and scripts	☐ Passports and immunisation records
☐ Contact lenses or prescription glasses☐ Games, books and puzzles for entertainment	☐ Bank account and credit card numbers
☐ Esky and ice	☐ Inventory of household contents
☐ Ensure you have enough cash on hand to	☐ Important phone numbers
last one week D Fuel for car	☐ Family records such as birth and marriage certificates
☐ Pet food and supplies	☐ USB with the above documents saved electronically

Use this checklist when packing and updating your emergency kit.

Water	lools and supplies	☐ Tools for temporary repairs
☐ Water in plastic containers	☐ Cooking facilities such as gas BBQ/camping stove	☐ Rope and chains for securing outdoor items
☐ A three day supply; minimum 4L of water per person, per day	☐ Plates, bowls, cups, utensils (paper or plastic plates don't	☐ Extension cords and power boards
Food	require washing)	☐ Plastic sheeting or tarps
☐ Minimum three day supply	☐ Battery operated radio	First aid kit
☐ Ready to eat canned meats, fruit and vegetables	□ Battery operated torches□ Spare batteries	☐ Replace any used contents
☐ Canned juices, milk and soups	☐ Utility knife	Clothing and bedding
☐ Staples such as sugar, pepper, salt and high energy foods such as peanut butter, honey, jams and muesli bars	☐ Toilet paper ☐ Soap/detergent ☐ Personal hygiene items	 At least one complete change of clothing and footwear per person
☐ Vitamins	☐ Duct and masking tape	☐ Long sleeve shirts and trousers
☐ Food for babies, children, elderly persons or any special	☐ Matches in waterproof container	□ Sturdy shoes □ Rain gear
dietary requirements	☐ Disinfectant	☐ Blankets or sleeping bags
☐ Comfort foods such as biscuits, lollies, cereals, coffee and tea	☐ Mobile phone and charger☐ Insect repellent and sunscreen	☐ Hats and work gloves☐ Sunglasses

3. Consider your shelter and evacuation options (including major transportation routes).

Shelter and Evacuation Options

- 1. Seek shelter outside of Townsville.
- 2. Seek shelter with family and/or friends located outside the risk area.
- 3. Seek shelter at an accommodation facility (e.g. motel).
- 4. Seek shelter at an identified Public Cyclone Shelter or Place of Refuge.

If you are self-evacuating and will not be staying within an identified Shelter, please register your location via the "Register, Find, Reunite" system available on the Australian Red Cross website. (N.B. this will be activated at the time of the pending disaster).

4. Tune into warnings. Authorities will advise which zones need to evacuate.

Emergency Alert System

Townsville City Council utilises the Queensland Government's "Emergency Alert System". The "Emergency Alert System" is the national telephone based emergency warning system that sends voice messages to landlines (based on the location of the handset) and text messages to mobile phones (based on the location of the mobile phone).

N.B. Authorities will advise of evacuations by the coloured zones, NOT streets or suburbs.



TOWNSVILLE EMERGENCY CONTACTS

SERVICE	NUMBER
Emergency Calls	000
State Emergency Service (SES) Tarping/branches down	13 25 00
Queensland Police Service Policelink (non life-threatening calls)	000 13 14 44
Queensland Ambulance Service Queensland Ambulance Service (non life-threatening calls)	000 13 12 33
Queensland Fire and Emergency Services	000
Townsville City Council <i>Emergency after hours, flood information, dengue outbreaks, sun safety information</i>	13 48 10
Emergency Management and Disaster Dashboard	13 22 96
Ergon Energy Loss of supply and emergencies	13 16 70
Origin Energy Natural and LPG Gas emergencies (leaks only)	1800 808 526
North Regional Gas LPG Gas emergencies	4774 5111
Telstra	13 22 03
Optus	13 13 44
Townsville Hospital and Health Service	4433 1111
Department of Transport and Main Roads Road closures	13 19 40
Translating and Interpreting Service	13 14 50
Veterinary Emergency Centre and Hospital	4781 3600

TUNE INTO WARNINGS

Tune into your local radio station for the latest emergency information.

ABC North QLD 630AM
Triple M 102.3FM
Hit FM 103.1FM
Power100 100.7FM
Star 106.3FM
Triple T 103.9FM
4K1G 107.1FM
Live FM 99.9FM

WEBSITE

- townsville.qld.gov.au
- disaster.townsville.qld.gov.au
- 🔄 bom.gov.au

SOCIAL MEDIA

■ Townsville Disaster Information

APPENDIX 4 WATER & SEWER PLANNING REPORT



94 BERGIN ROAD, CRANBROOK ROOMING ACCOMMODATION DEVELOPMENT

WATER SUPPLY & SEWERAGE PLANNING REPORT

Date: 22 April 2025 (Revision A)

TABLE OF CONTENTS

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3	W	ATER SUPPLY PLANNING	2
	3.1	Water Demand	2
	3.2	Water Supply Assessment & Network Modelling	2
4	SE	WAGE SYSTEM PLANNING	6
	4.1	Sewage Infrastructure Capacity	7

APPENDICES

Appendix A	Development Plans
Appendix B	Water Network Modelling & Results
Appendix C	Sewer Network Modelling & Results

REPORT	REPORT AUTHORISATION				
Revision	Revision Date	Details	Prepared by	Signature	
А	22/04/2025	Original Report	Desmond Moseley (RPEQ 7565)	moseley	

1 INTRODUCTION

A rooming accommodation development is proposed at 94 Bergin Road, Cranbrook. This site is located on the north-west corner on Isabella Crt and Bergin Rd. An existing single dwelling is location on the site. The dwelling is an existing rooming accommodation with 5 rooms. The site is illustrated on the Townsville Council GIS image below.

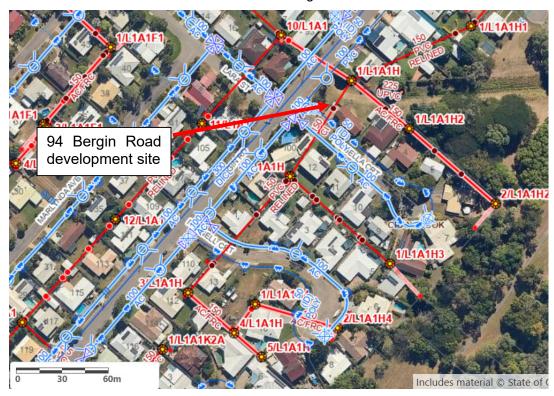


Figure 1 – Development Site Location

It has been advised from the client that the intent is to construct an additional two buildings on the site. These two buildings will be additional rooming accommodation. The proposed development plans are provided in Appendix A. The development plans illustrate a total of 16 rooms in the three buildings (ie 11 additional rooms and 5 existing rooms). The client has advised that there is the potential for the building layouts to be adjusted to have up to 18 rooms. The water & sewer assessment has therefore been undertaken based on the upper development yield of 18 rooms.

To ensure the rooming accommodation development can be adequately serviced with a potable water supply and sewage system in accordance with Council standards, an assessment of the system capacities have been undertaken. This report summarises the assessment of the existing water and sewerage network with this illustrating:

- The theoretical modelling shows the existing water network, including the DN100 AC water main along the southern side of Bergin Rd is adequately sized to service the development.
- The existing DN150, DN225 and DN300 gravity sewer system from the development site to PS L1A (Barellan St) has sufficient capacity to service the development.
- No water or sewer system upgrades are required to service the development.

The water network modelling and sewer system capacity assessment undertaken for this rooming accommodation development is summarised in the following report sections.

2 POPULATION ASSESSMENT

The following section provides the equivalent population assessment for the proposed rooming accommodation development on 94 Bergin Rd. The equivalent population assessment has been developed based on the proposed use on the site, being rooming accommodation. The rooming accommodation will allow for one (1) person per room only. The following table provides the water and sewer equivalent population for the development.

Table 2.1 – Water & Sewer Equivalent Population Assessment

	Number	Rate	EP
Rooms	18	1.0	18 EP

The above equivalent population assessment has been used in the water supply and sewer system capacity assessment for the proposed development.

3 WATER SUPPLY PLANNING

3.1 Water Demand

Water demands have been calculated in accordance with Townsville City Council planning scheme and its latest amendments. The following table provides the "residential" water demand parameters for the Townsville Planning Scheme for each equivalent person (EP).

Table SC6.4.3.21.2 Water supply unit demand parameters

Parameter	Unit Demand	Peaking Factor
Average Day (AD)	600 L/day/EP	
Mean Day Max Month (MDMM)	900 L/day/EP	1.5 AD
Peak Day (PD)	1125 L/day/EP	1.25 MDMM
Peak Hour (PH)	0.0333 L/s/EP	2.56 PD

The peak hour residential water demands have been applied to the proposed rooming development, giving a peak water demand of 18 EP x 0.033 l/s/EP = 0.594 l/s.

In addition to the above, as the development is residential, a 15 l/s fire flow is applicable in accordance with Council's planning and design guidelines. This fire flow has been used to assess the theoretical performance of the water network.

3.2 Water Supply Assessment & Network Modelling

The existing site for the proposed rooming accommodation development is on the north-west corner on Isabella Crt and Bergin Rd in Cranbrook. The existing water infrastructure that services the site includes:

- A DN100 AC water main along the south-eastern side of Bergin Rd. This is along the frontage of the proposed development. There is also a DN63 PE water main along the Isabella Crt frontage of the development site.
- The existing DN100 AC water main extends to the intersection north east along Bergin Rd to the intersection with Alice St where it connects to an existing DN300 AC/DICL water main. The DN300 trunk water main runs along the full length of Bergin Rd.

- The DN300 AC/DICL water main connects to an existing DN600 AC trunk water main at the intersection of Bergin Rd and Nathan St.
- The DN600 AC trunk water main extends to the south along Nathan St (across Ross River as 4 x DN300 MSCL pipes attached to the Bridge) and then through to the intersection of Angus Smith Drv. The DN600 main connects to a DN825 MSCL main at Angus Smith Drv. The DN825 MSCL main is the trunk outlet main from the Douglas 1A/1B reservoir.

The following extract from the Council GIS illustrates the existing water infrastructure that services the development site in Cranbrook.



Figure 3.1 - Council GIS Plot

Theoretical water network modelling has been performed to assess the capacity of the existing reticulation network. The modelling was undertaken using the Council's WaterGEMS network model for both the peak hour demands and fire flows.

The theoretical WaterGEMS network modelling results with the inclusion of the water demands from the proposed development shows:

- The existing DN100 AC water main along Bergin Rd frontage is shown to be adequately sized to service the development with peak hour and fire flows.
- The peak hour pressures at 6:30 pm (ie the peak residential demand period) are reduced to 413 kPa at the development site. The water pressures in the adjacent residential area are reduced to around 400 kPa. This meets the minimum pressure requirement of 220 kPa.
- The headloss gradient along the existing DN100 AC water main along Bergin Rd is up to 0.010 m/m with the pipe velocities up to 0.68 m/s. The headloss gradient in above the recommenced 0.005 m/m value however the pipe velocity is well within the

maximum recommenced value of 2.5 m/s. As this is an existing water main, having a higher headloss gradient does not adversely impact on the water network performance and peak hour water pressures in this area. It is also noted that the headloss gradient on the existing DN100 AC water main was higher than the 0.005 m/m value prior to the additional demands from the rooming accommodation development.

- With the inclusion of the 15 l/s fire flow the water pressures are reduced to 337 kPa within the water main. This is the pressure at 6:30pm and is concurrent with the peak residential demand period and meets the minimum pressure requirement of 120 kPa.
- The fire flow velocity along the DN100 reticulation main on Bergin Rd is 1.52 m/s and meets the Council design standards of being less than 5.0 m/s.
- The WaterGEMS figure and results table are provided in Appendix B.

The above theoretical water network modelling shows that the proposed development is able to be serviced with a reticulated water supply that meets Council's standards with no upgrades required.

The following figure illustrates the peak hour demands and residual water pressure at the proposed rooming development site.

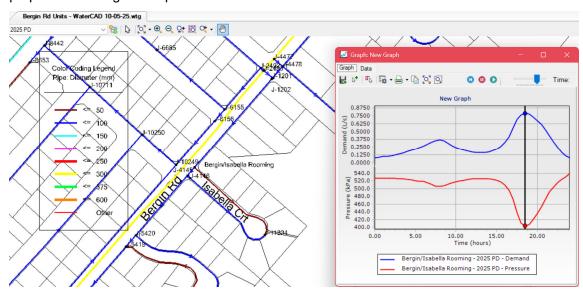


Figure 3.2 - Peak Hour Water Demand & Pressures

The following figure illustrates the water pressure at the development site with the inclusion of the 15 l/s fire flows.

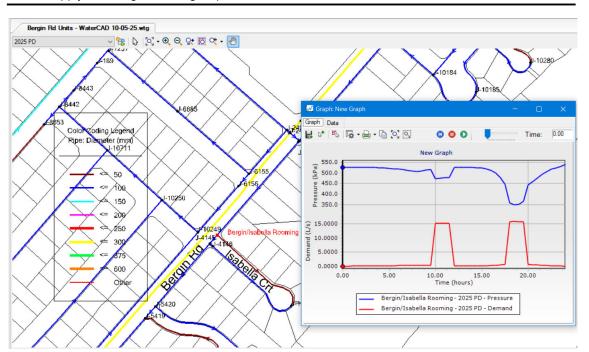


Figure 3.3 – 15 l/s Fire Flow Water Demand & Pressures

Additional hydrant testing could be undertaken if required on Bergin Rd to confirm the actual performance of the network, with this subject to the building code requirements for the site.

4 SEWAGE SYSTEM PLANNING

The existing site for the proposed rooming accommodation development is currently serviced with a reticulated gravity sewer system. The existing gravity sewer system consists of:

- A DN150 AC sewer is located along the north eastern boundary of the development site. Existing MH 1/L1A1H is located on the DN150 AC sewer and within the site. The DN150 sewer extends to the north west and under Bergin Rd to MH 10/L1A1.
- The sewer increases to a DN225 sewer at MH 10/L1A1 and extends to the north west through to MH 5/L1A1 that is located between Jannila Ave and Ross River Rd. The sewer increases in size to a DN300 AC pipe at MH 5/L1A1.
- The DN300 sewer extends to the north east (parallel to Ross River Rd) through to PS L1A (Barellan) that is located opposite the intersection of Jandera St and Barellan St. PS L1A pumps sewage to the east to discharge into a trunk sewer in the catchment of major PS L14A.

Figure 4.1 below is a plot from the Council GIS that illustrates the existing DN150, DN225 & Dn300 sewer system that services the development site. The capacity of the existing sewer system is provided in the following report sections.

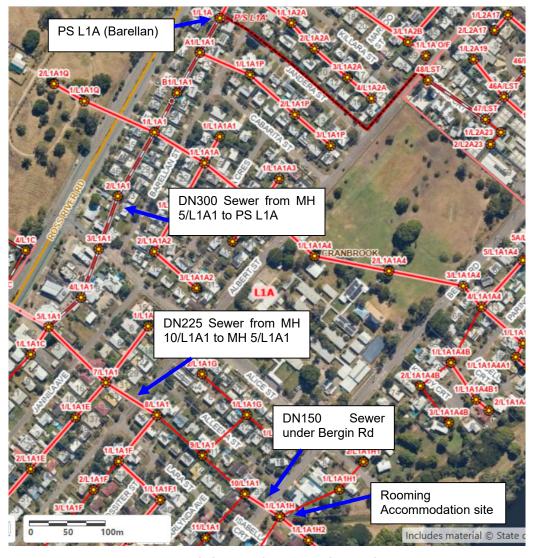


Figure 4.1 – GIS Plot of Existing Sewer System

4.1 Sewage Infrastructure Capacity

The capacity of the existing gravity sewer system to cater for the proposed rooming accommodation development was assessed using the SewerGEMS model developed for the Louisa suburbs of Townsville.

The SewerGEMS model includes the existing reticulation and trunk gravity sewer system from the development site through to existing PS L1A (Barellan St). The additional residential equivalent population has been added to MH 1/L1A1H which is located within the proposed development site.

The additional residential equivalent population loading on MH 1/L1A1H is illustrated in the extract from the SewerGEMS model on Figure 4.2 below.

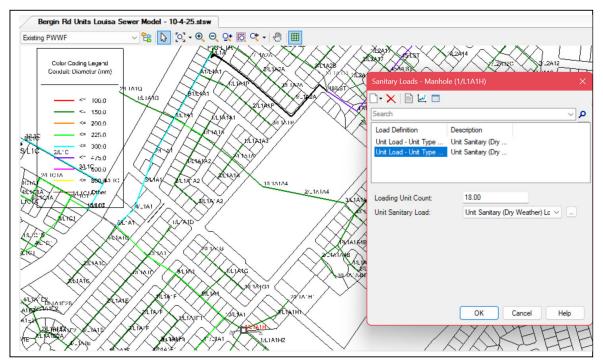


Figure 4.2 - Additional Residential Loading on MH 1/L1A1H

With the inclusion of the additional equivalent population loading on the existing gravity sewer system, the SewerGEMS model has illustrated:

- The existing DN150 sewer from MH 1/L1A1H2 to MH 10/L1A1 (being the reticulation gravity sewer that will service the development site) flows up to 26% full for the peak wet weather flows.
- The existing DN225 sewer from MH 10/L1A1 to MH 5/L1A1 (being the reticulation sewer that runs to the north-west to near Ross River Rd) flows up to 47% full for the peak wet weather flows.
- The final section is an existing DN300 trunk sewer that runs from from MH 5/L1A1 into PS L1A (being the trunk sewer that runs the north-east at the back of the lots between Ross River Rd and Barellan St) flows up to 45% full for the peak wet weather flows.
- All the existing sewers easily flow less than 75% full which is the maximum value allowable in the CTM code.

The following Figure 4.3 provides the flows and performance of the existing gravity sewer system with the inclusion of the additional loading from the proposed rooming accommodation development. A larger version of the modelling results is provided in Appendix C.


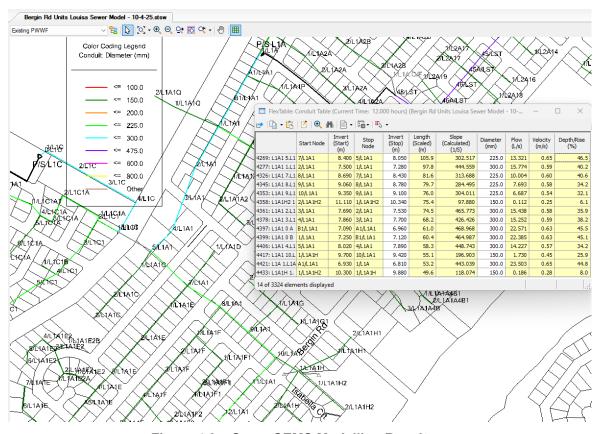


Figure 4.3 – SewerGEMS Modelling Results

The above assessment illustrates the existing gravity sewer system has sufficient capacity to cater for the proposed rooming development at 94 Bergin Rd, Cranbrook.

APPENDIX A RESIDENTIAL ROOMING DEVELOPMENT PLANS

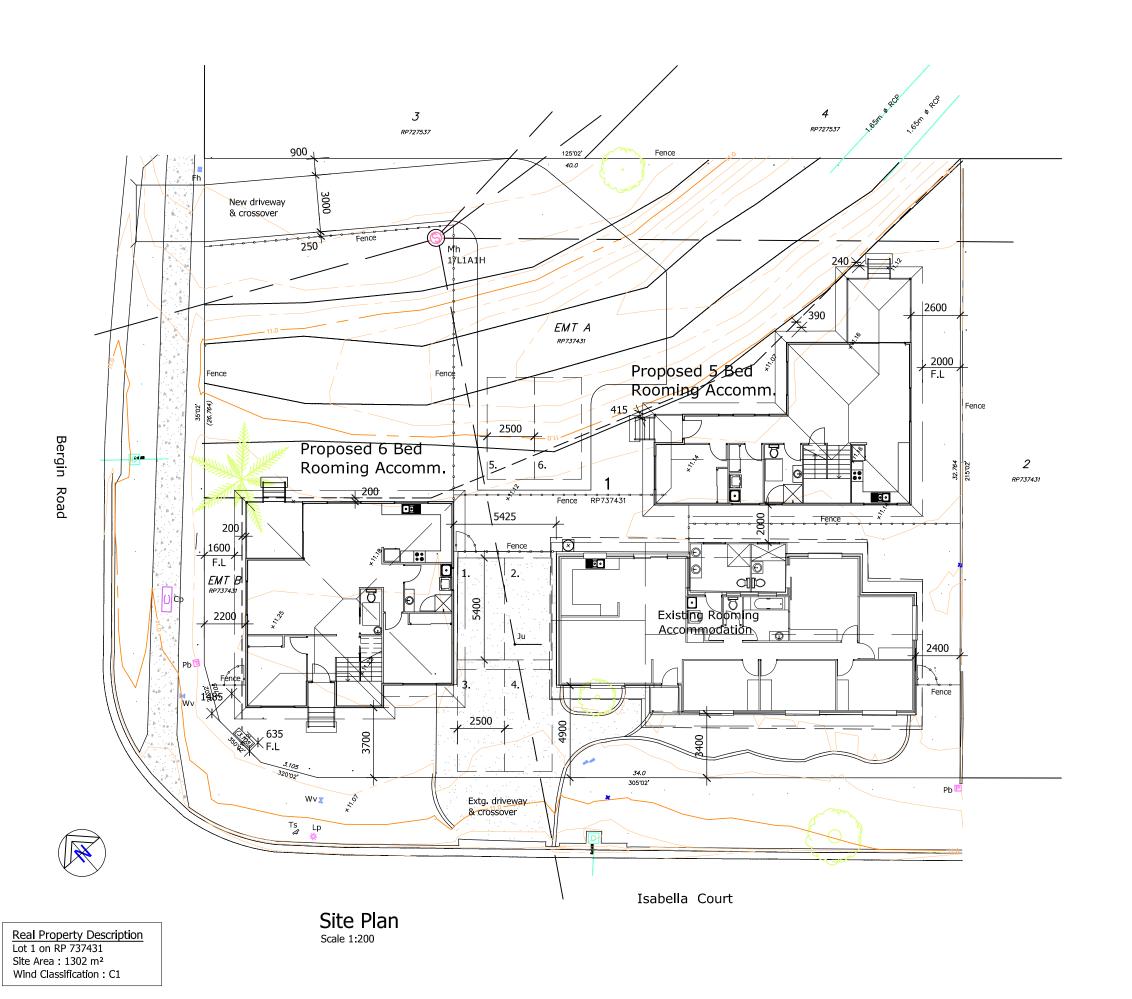

General Notes

1. Do not scale off drawing check all dimensions & levels on site before commencing work, including location of all services.

2. Comply with all Local Authority & Building Code of Australia 2022 regulations & all relevant Australian Standard Codes.

3. Installation of all materials to comply with Manufacturer's Specifications.

4. Notwithstanding Inspection by an Engineer or Building Certifier, it is the Builder's responsibility to ensure that all works are constructed in accordance with the Building Approval Drawings.

5. Substitution of any structural member, & variation to any of the design, will void any responsibilities to Benson Building Designs for the performance of the building.

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Floor Level Raised to 900mm 24/09/24 Revision/Issue



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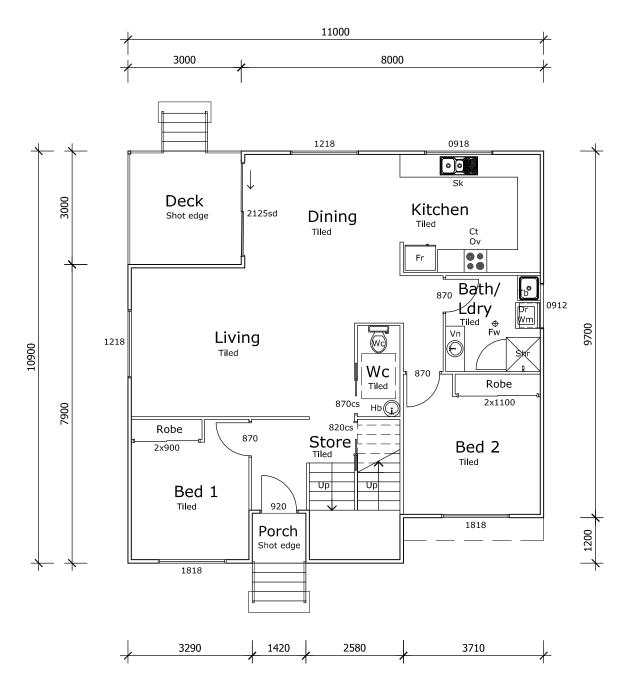
Call: 0416 936 452

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Project Name and Address

Proposed Rooming Accomm. Development Abel Family Trust Pl 94 Bergin Road, Cranbrook, Queensland


Project No. 2024-12	Dwg No. DD01	Issue B
Date March, 2024	Designed G.B	
Scale 1:200 @ A3	Drawn G.B	







Floor Areas Living: 105.14 m² Deck: 9.00 m² Porch: 1.44m² Overall: 115.58 m²

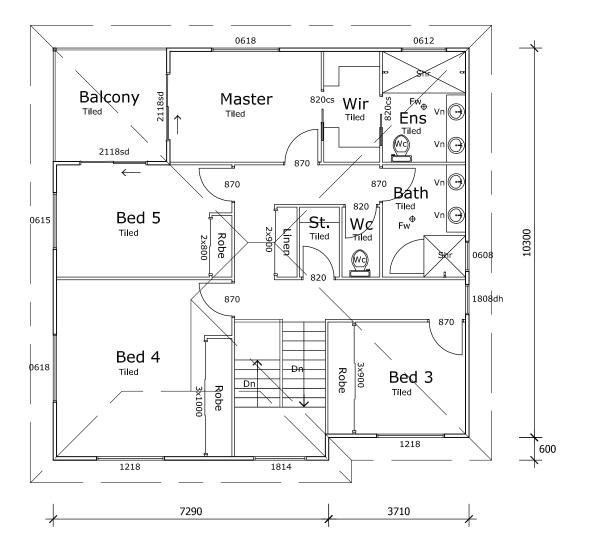

Upper Floor Plan Scale 1:100

Floor Areas Living: 108.74 m² Balcony: 9.00m² Overall : 117.74 m²

General Notes

1. Do not scale off drawing check all dimensions

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В	Floor Level Raised to 900mm	17/02/25
Α	Preliminary Design	24/09/24
No.	Revision/Issue	Date



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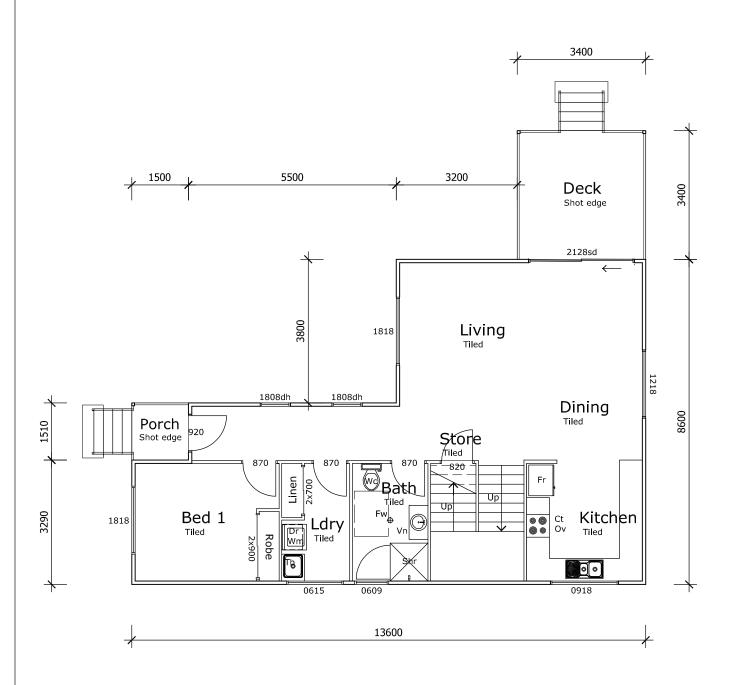
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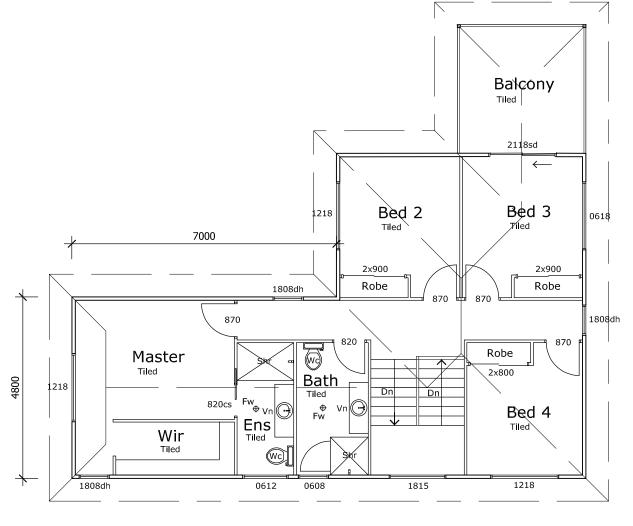
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Project Name and Address

Proposed Rooming Accomm. Development Abel Family Trust Pl 94 Bergin Road, Cranbrook, Queensland

Project No. 2024-12	Dwg No. DD02	Issue B
Date March, 2024	Designed G.B	
Scale 1:100 @ A3	Drawn G.B	





Ground Floor Plan Scale 1:100

Floor Areas Living: 88.25 m² Patio: 11.56 m² Porch: 2.10m² Overall: 101.92 m²

Upper Floor Plan
Scale 1:100

Floor Areas Living: 90.36 m² Balcony: 11.56m² Overall : 101.92 m²

General Notes

- 1. Do not scale off drawing check all dimensions

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Floor Level Raised to 900mm 24/09/24 Revision/Issue



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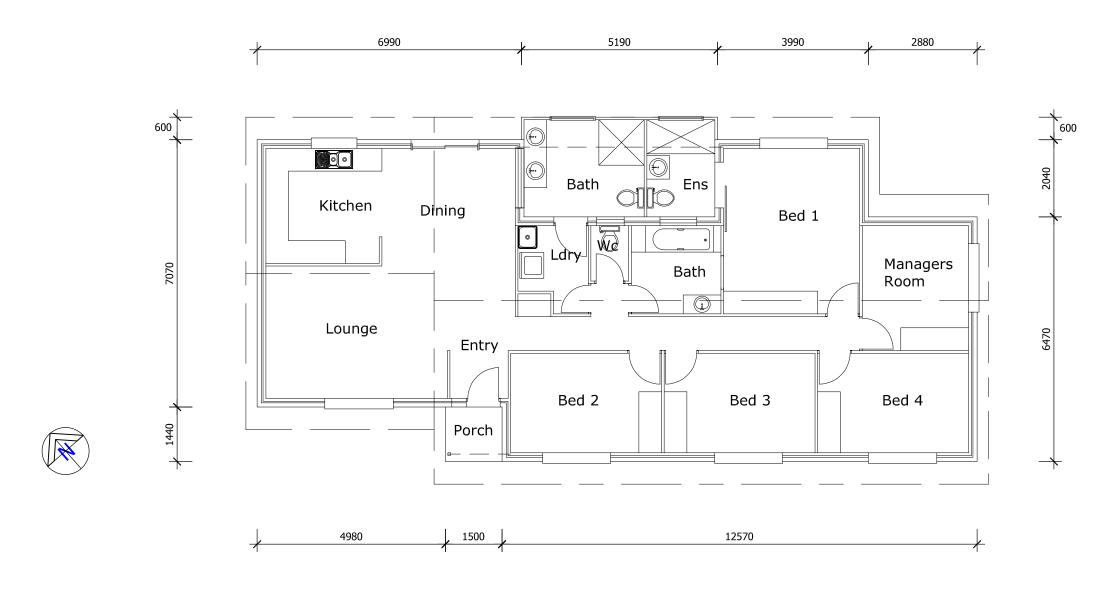
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Project Name and Address

Proposed Rooming Accomm. Development Abel Family Trust Pl 94 Bergin Road,

Cranbrook, Queensland

Project No. 2024-12	Dwg No. DD05	Issue B
_{Date} March, 2024	Designed G.B	
Scale 1:100 @ Δ3	Drawn G. B.	



Floor Areas Living: 150.02 m² Porch : 2.16m² Overall: 152.18 m²

Existing Floor Plan

Scale 1:100

General Notes

General Notes

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3. Installation of all materials to comply with Manufacturer's Specifications.

4. Notwithstanding inspection by an Engineer or Building Certifier, it is the Builder's responsibility to ensure that all works are constructed in accordance with the Building Approval Drawings.

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А	Preliminary Design	24/09/24
No.	Revision/Issue	Date



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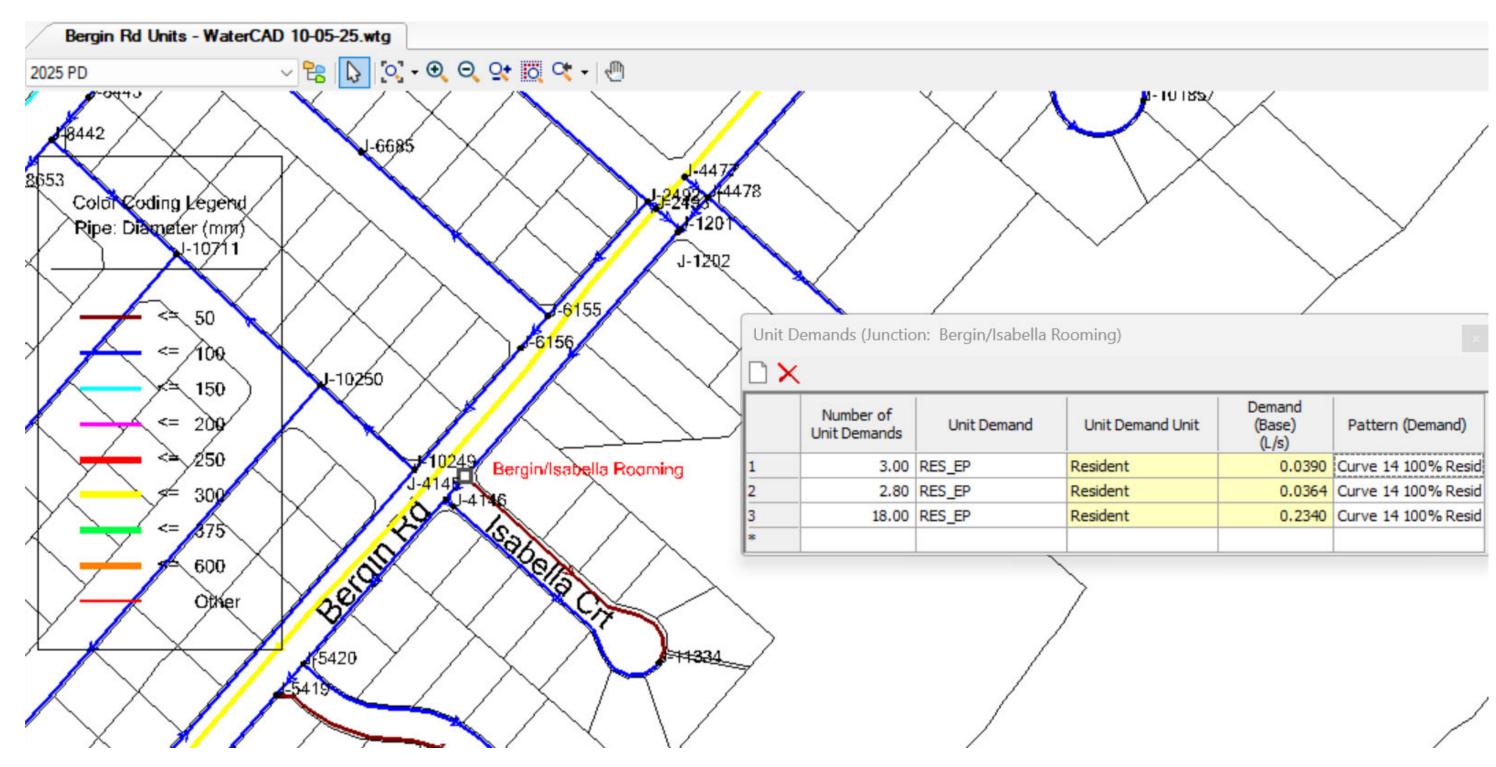
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Project Name and Address


Proposed Rooming Accomm. Development Abel Family Trust Pl 94 Bergin Road, Cranbrook, Queensland

Project No. 2024-12	Dwg No. DD08	Issue A
Date March, 2024	Designed G.B	
Scale 1:100 @ A3	Drawn G.B	

APPENDIX B WATERGEMS MODELLING RESULTS



WATERGEMS Model With 18 Rooms Development - Water Demand Added

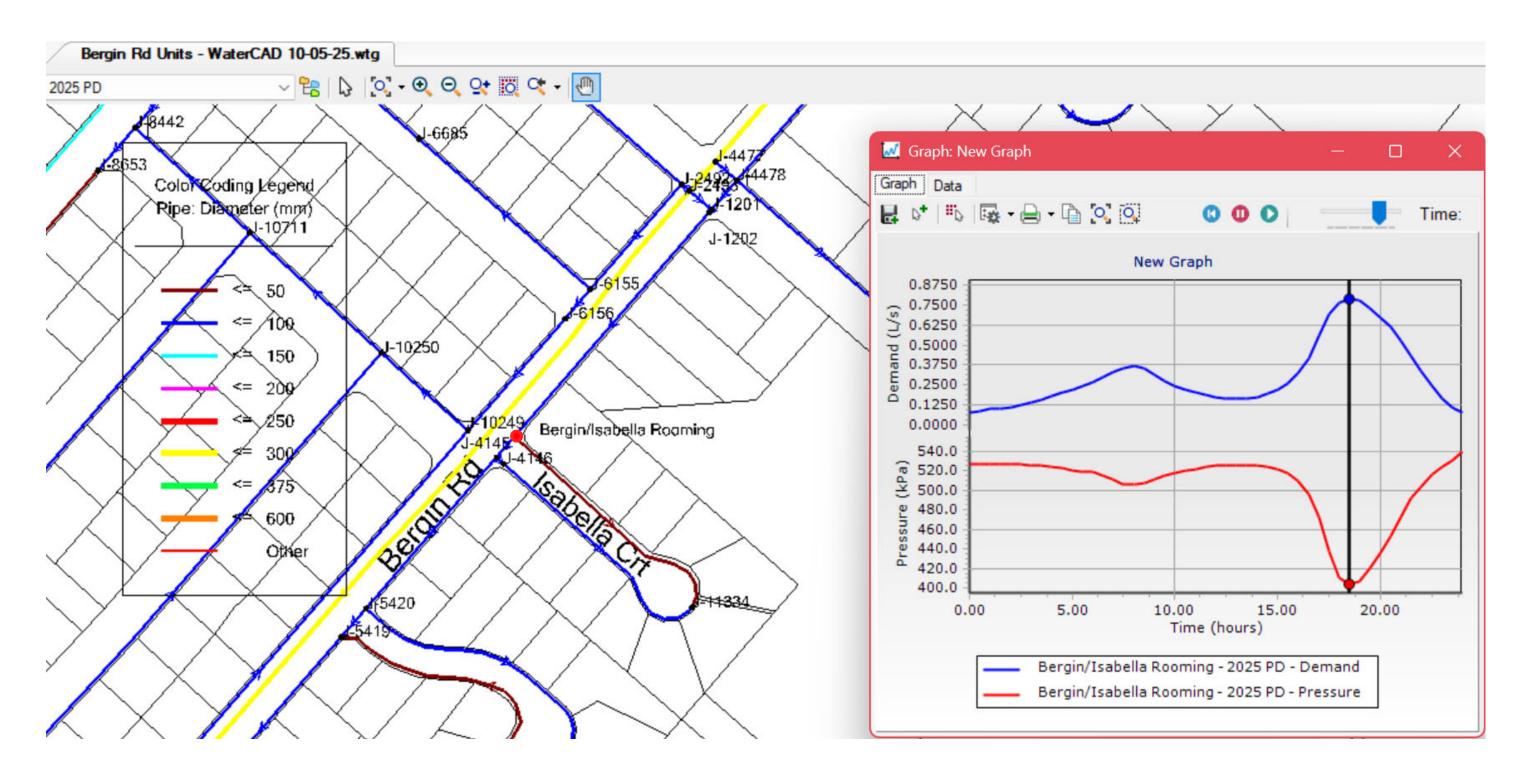

Peak Hour Pressure at Unit Development Node